BLUELINE

25 CENTRAL WAY, SUITE 400. KIRKLAND, WA 98033 P: 425.216.4051 F: 425.216.4052

WWW.THEBLUELINEGROUP.COM

AS NOTED PROJECT MANAGER: BRETT K. PUDISTS, PE PROJECT ENGINEER.

LYNDSEY MUNKEL, PE NADIA KROUMOVA

GROSS SITE AREA: GROSS FLOOR AREA: NUMBER OF LOTS PROPOSED: 14 PROPOSED USE: MINIMUM LOT SIZE ALLOWED: SETBACKS:

LOT COVERAGE:


BUILDING HEIGHT:

2.88 ACRES (125,315.52 SF)

30' MAX ABOVE ABE

SINGLE FAMILY 8,400 SF FRONT 20' (F), REAR 25' (R), SIDE 5' (S) (BUT 2 SIDE YARDS MUST EQUAL 15") ROW AND VEHICULAR ACCESS EASEMENT 10 40% MAX (LOT SLOPE LESS THAN 15%)

NO GUARANTEE THAT ALL UTILITY LINES ARE SHOWN, OR THAT THE LOCATION. SIZE AND MATERIAL IS ACCURATE. THE CONTRACTOR SHALL UNCOVER ALL INDICATED PIPING WHERE CROSSING, INTERFERENCES, OR CONNECTIONS OCCUR PRIOR TO TRENCHING OR EXCAVATION FOR ANY PIPE OR STRUCTURES, TO DETERMINE ACTUAL LOCATIONS, SIZE AND MATERIAL. THE CONTRACTOR SHALL MAKE THE APPROPRIATE PROVISION FOR PROTECTION OF SAID FACILITIES. THE CONTRACTOR SHALL NOTIFY <u>ONE CALL</u> AT 8-1-1 (WASHINGTON811.COM) AND ARRANGE FOR FIELD LOCATION OF EXISTING FACILITIES BEFORE CONSTRUCTION.

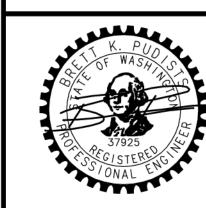

3/1/19 13-118

SHEET NAME: CV-01

₹ % ii © 2019 THE BLUELINE GROUP


✓ PIPE FLOW


BLOW OFF

]H[GATE VALVE


TEE W/ CONC BLOCKING

↓ BEND W/ CONC BLOCKIN

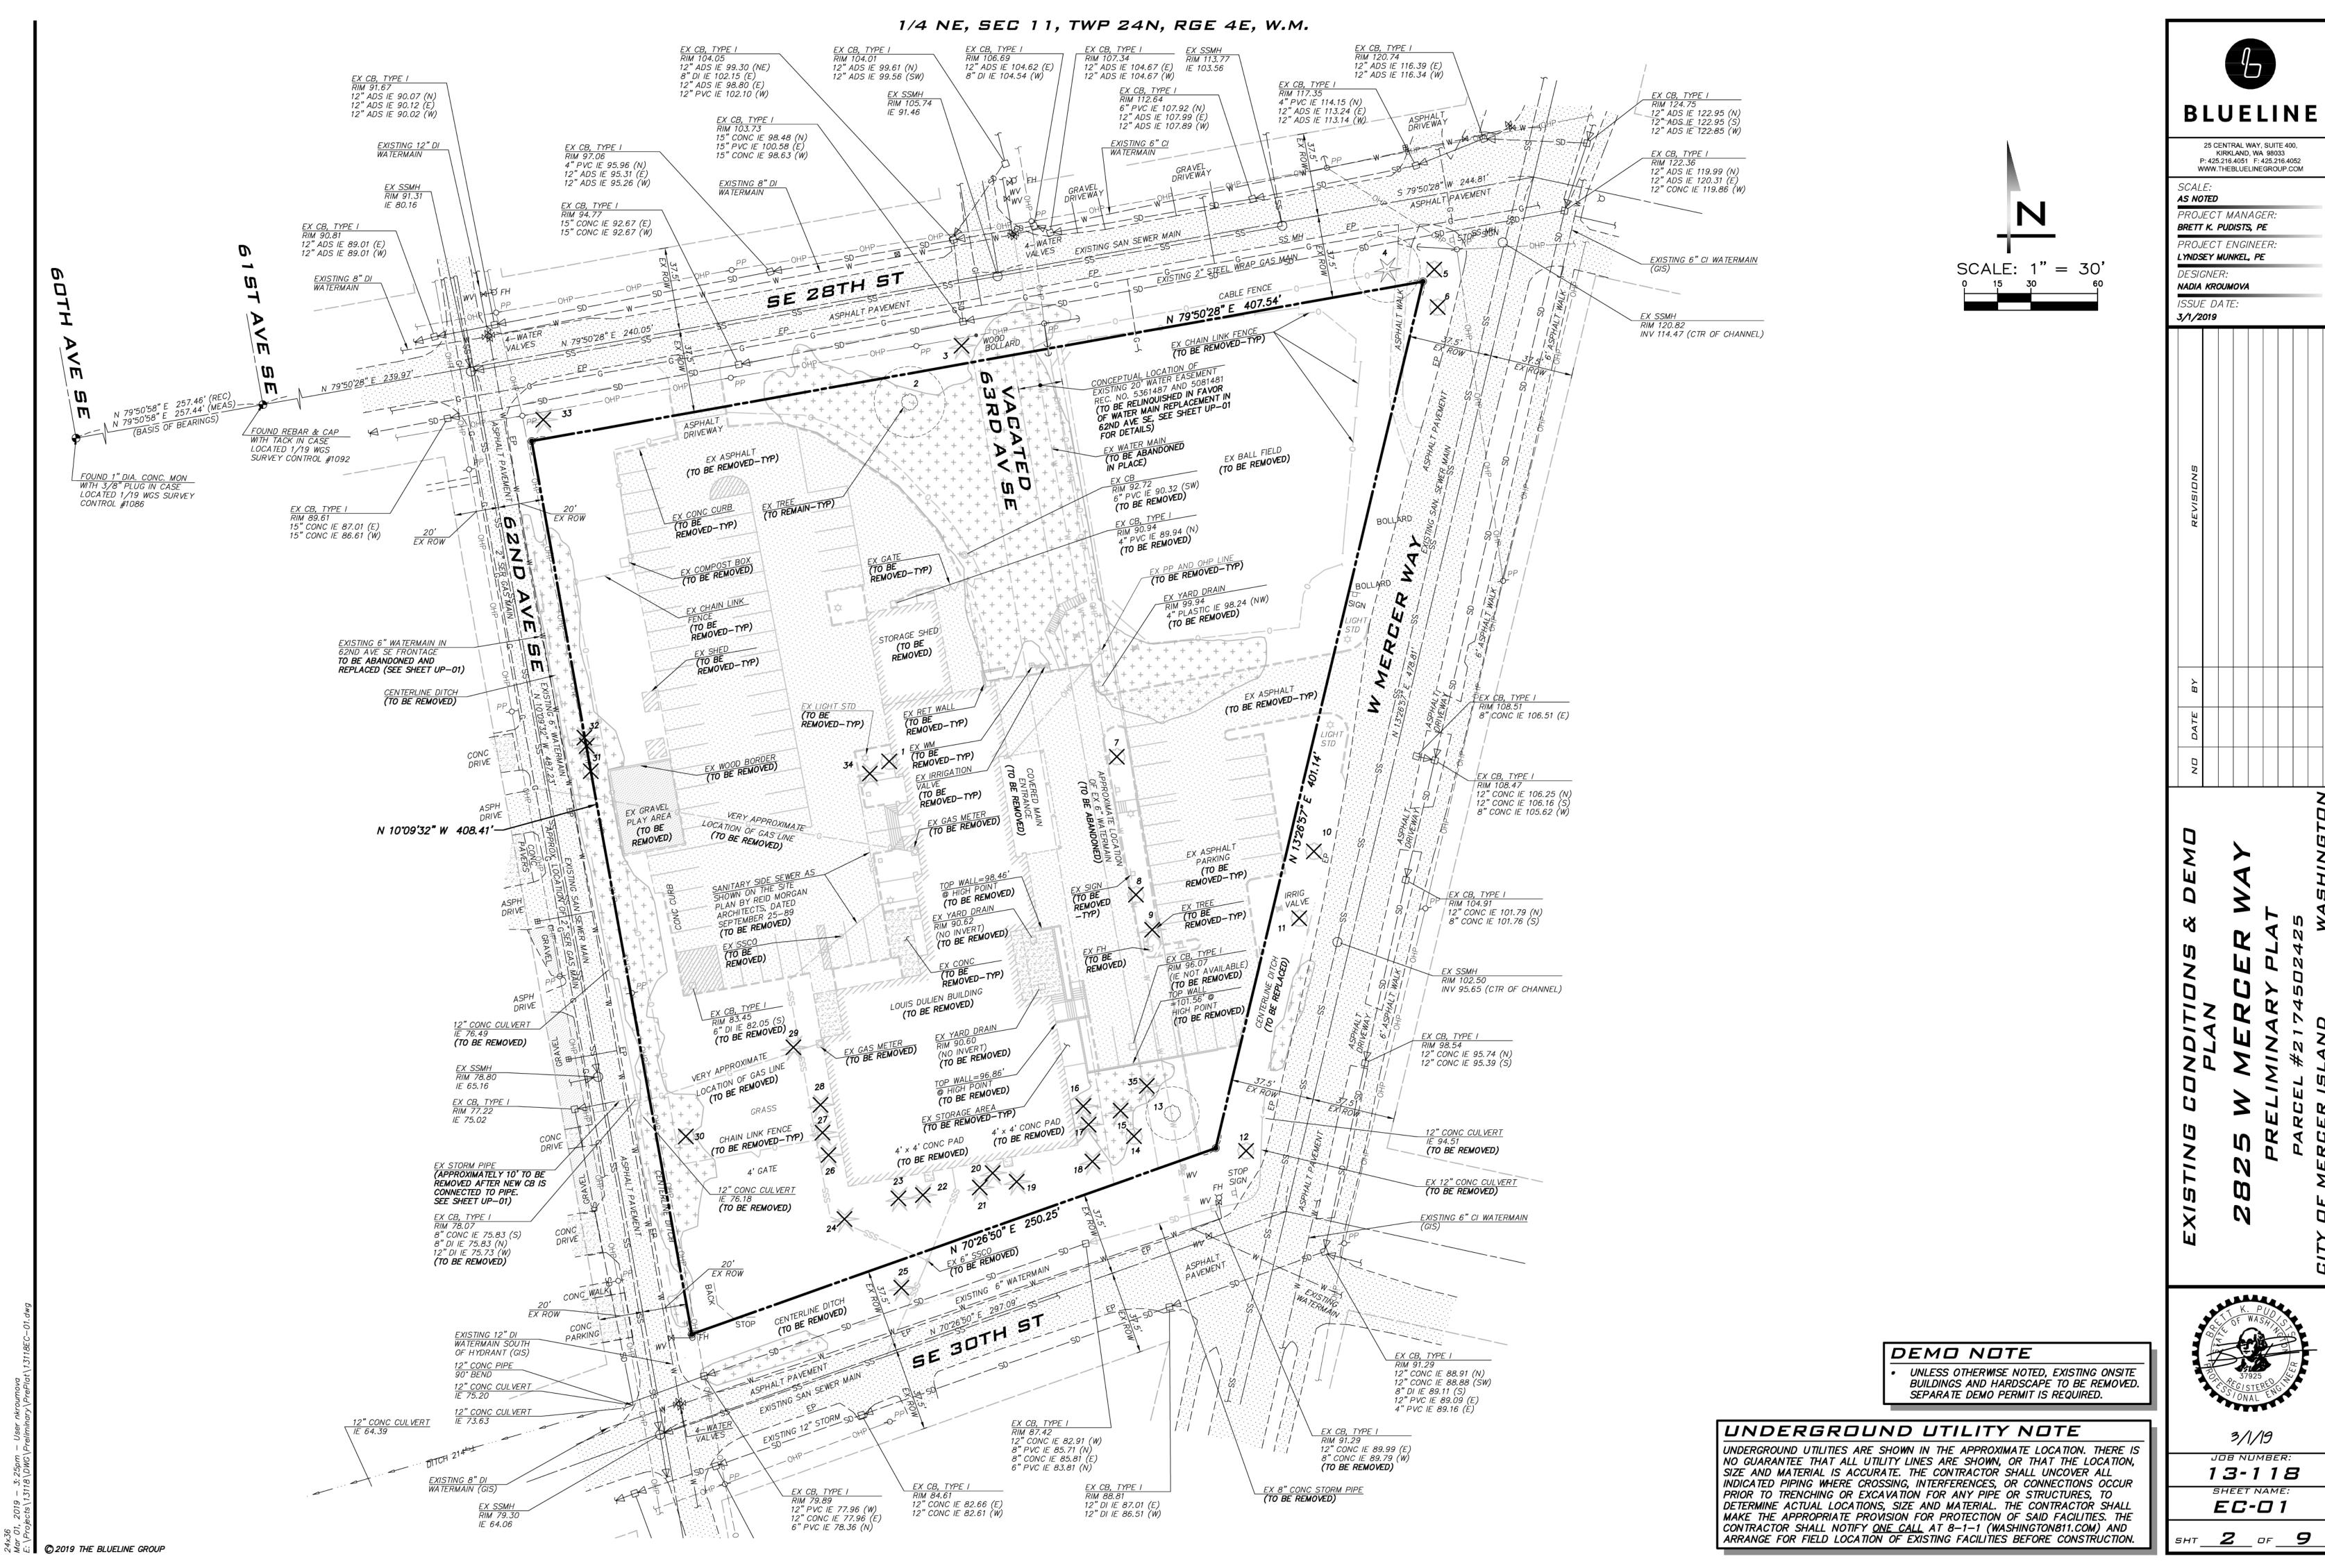

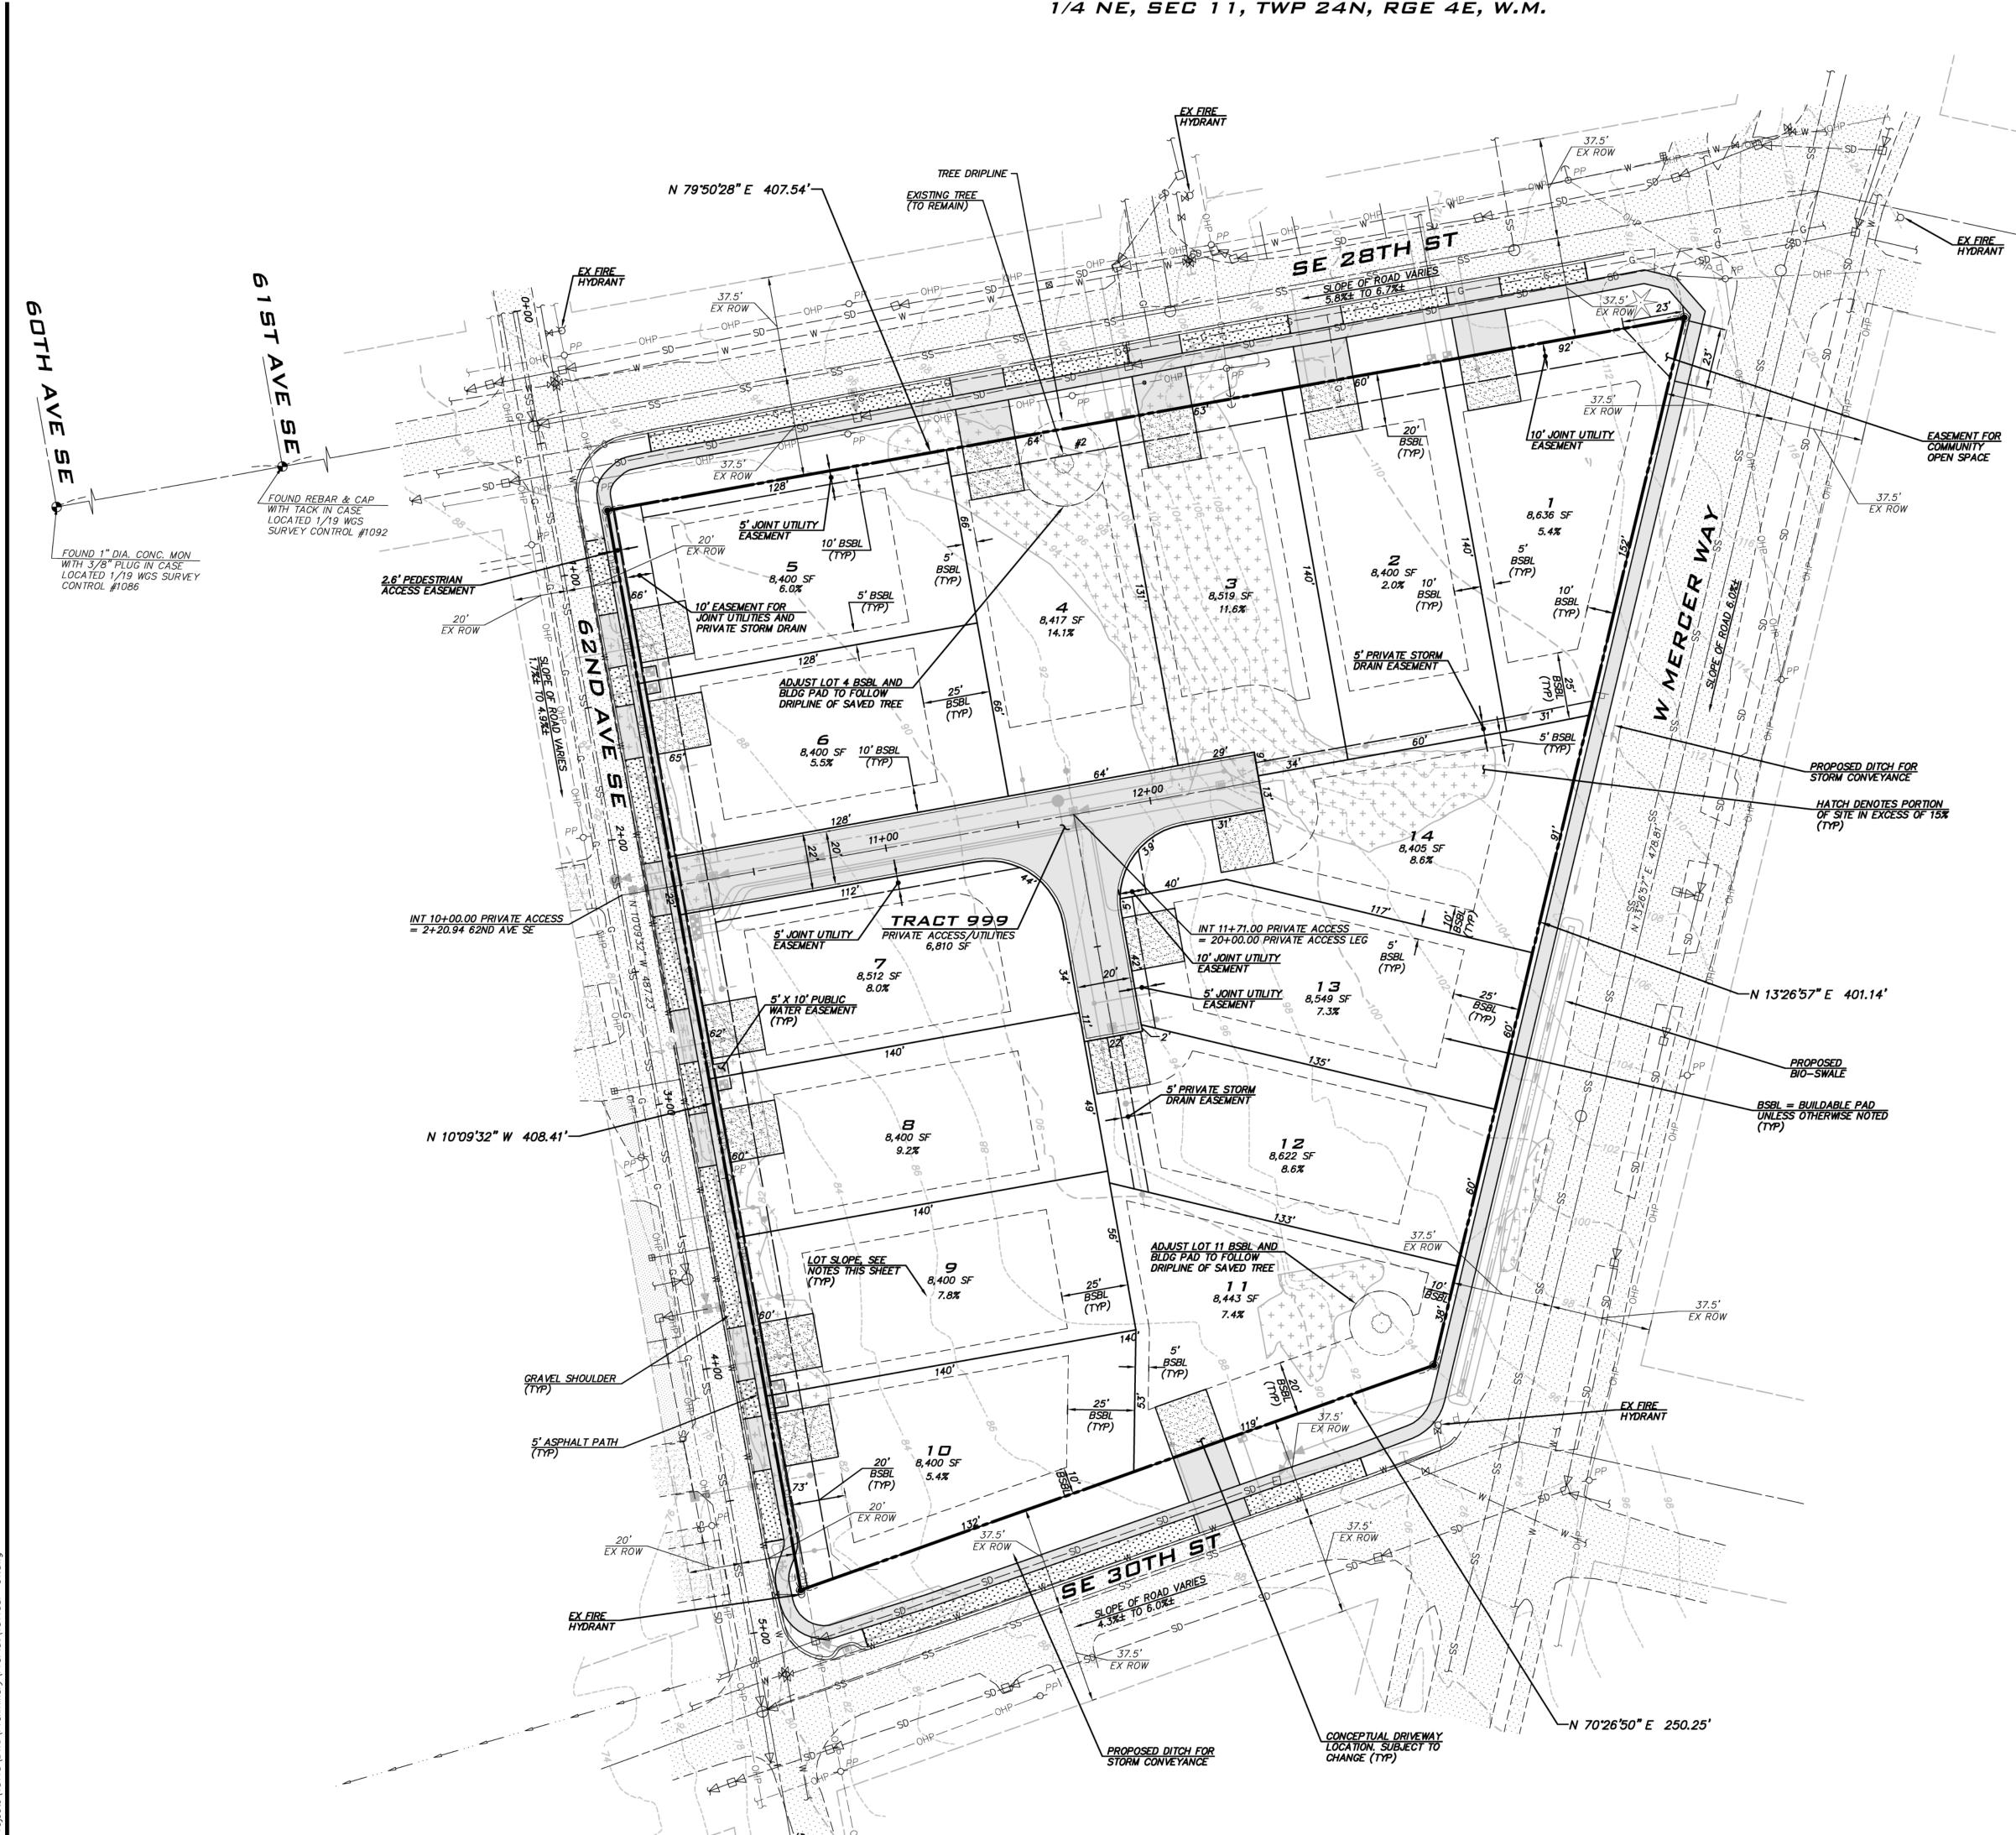

2019 THE BLUELINE GROUP

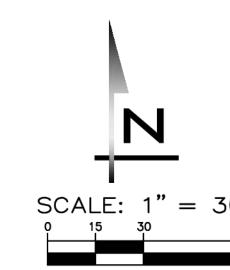

LOT COVERAGE TABLE

1	LOT NO.		LOT COVERAGE		PORTION OF LANDSCAPING AREA THAT CAN BE
-		(SF)	(SF)*	AREA (SF)*	HARDSCAPE (SF)**
-	1	8,644	3,458	5,186	778
-	2	8,400	3,360	5,040	756
-	3	8,417	3,367	5,050	758
-	4	8,417	3,367	5,050	758
-	5	8,401	3,360	5,041	756
-	6	8,530	3,412	5,118	768
-	7	8,512	3,405	5,107	766
-	8	8,400	3,360	5,040	756
-	9	8,400	3,360	5,040	756
-	10	8,403	3,361	5,042	756
-	11	8,423	3,369	5,054	758
-	12	8,639	3,456	5,183	778
-	13	8,545	3,418	5,127	769
-	14	8,441	3,376	5,065	760
	*LOT CO	VERAGE (40	% OF THE LOT AF	REA) AND LANDS	CAPING AREA (60% OF THE

LOT AREA) ARE BASED ON THE EXISTING SLOPE ACROSS THE LOT (<15%). **REQUIRED LANDSCAPING AREA SHALL CONSIST OF SOFSCAPE IMPROVEMENTS EXCEPT WHERE USED FOR HARDSCAPE IMPROVEMENTS. 9% OF THE LOT AREA MAY CONSIST OF HARDSCAPE IMPROVEMENTS.

FIRE SPRINKLERS

 NEW SINGLE FAMILY RESIDENCES REQUIRE A MINIMUM OF 13D SPRINKLER SYSTEM.

LOT SLOPES



DENOTES AREAS OF SLOPE ≥ 15%.

X.X**%** SLOPE OF LOT =

((HIGHEST LOT ELEVATION - LOWEST LOT ELEVATION) / HORIZONTAL DISTANCE) X 100

CRITICAL AREAS NOTE

NO CRITICAL AREAS WERE IDENTIFIED ON SITE.

NEAREST FIRE HYDRANT

EXISTING FIRE HYDRANTS ARE LOCATED NEAR EACH STREET INTERSECTION AND HAVE BEEN LABELED FOR CONVENIENCE.

BUILDING HEIGHTS

PROPOSED BUILDINGS WILL BE DESIGNED IN THE FUTURE

AS PART OF THE BUILDING PERMIT PROCESS.

AVERAGE BUILDING ELEVATION GRADE POINTS TO BE DETERMINED BASED ON PROPOSED BUILDINGS BY OTHERS.

NOTES

- SEE LEGEND ON SHEET CV-01.
- REFER TO SHEET EC-01 FOR EXISTING FEATURES THAT WILL BE REMOVED.
- REFER TO SHEET GP-01 FOR PRELIMINARY GRADING PLAN.
- REFER TO SHEET UP-01 FOR PRELIMINARY UTILITY PLAN.
- SEE SHEET RS-01 FOR ROAD SLOPES AND CROSS SECTIONS.
- SEE SHEET TR-01 FOR TREE NUMBERS AND RETENTION SUMMARY.
- DIRECT VEHICULAR ACCESS TO W MERCER WAY IS PROHIBITED.

UNDERGROUND UTILITY NOTE

UNDERGROUND UTILITIES ARE SHOWN IN THE APPROXIMATE LOCATION. THERE IS NO GUARANTEE THAT ALL UTILITY LINES ARE SHOWN, OR THAT THE LOCATION, SIZE AND MATERIAL IS ACCURATE. THE CONTRACTOR SHALL UNCOVER ALL INDICATED PIPING WHERE CROSSING, INTERFERENCES, OR CONNECTIONS OCCUR PRIOR TO TRENCHING OR EXCAVATION FOR ANY PIPE OR STRUCTURES, TO DETERMINE ACTUAL LOCATIONS, SIZE AND MATERIAL. THE CONTRACTOR SHALL MAKE THE APPROPRIATE PROVISION FOR PROTECTION OF SAID FACILITIES. THE CONTRACTOR SHALL NOTIFY ONE CALL AT 8-1-1 (WASHINGTON811.COM) AND ARRANGE FOR FIELD LOCATION OF EXISTING FACILITIES BEFORE CONSTRUCTION.



25 CENTRAL WAY, SUITE 400, KIRKLAND, WA 98033 P: 425.216.4051 F: 425.216.4052 WWW.THEBLUELINEGROUP.COM

AS NOTED PROJECT MANAGER:

BRETT K. PUDISTS, PE PROJECT ENGINEER:


LYNDSEY MUNKEL, PE NADIA KROUMOVA

ISSUE DATE: 3/1/2019

3/1/19

13-118 SHEET NAME: SP-01

3 □F **9**

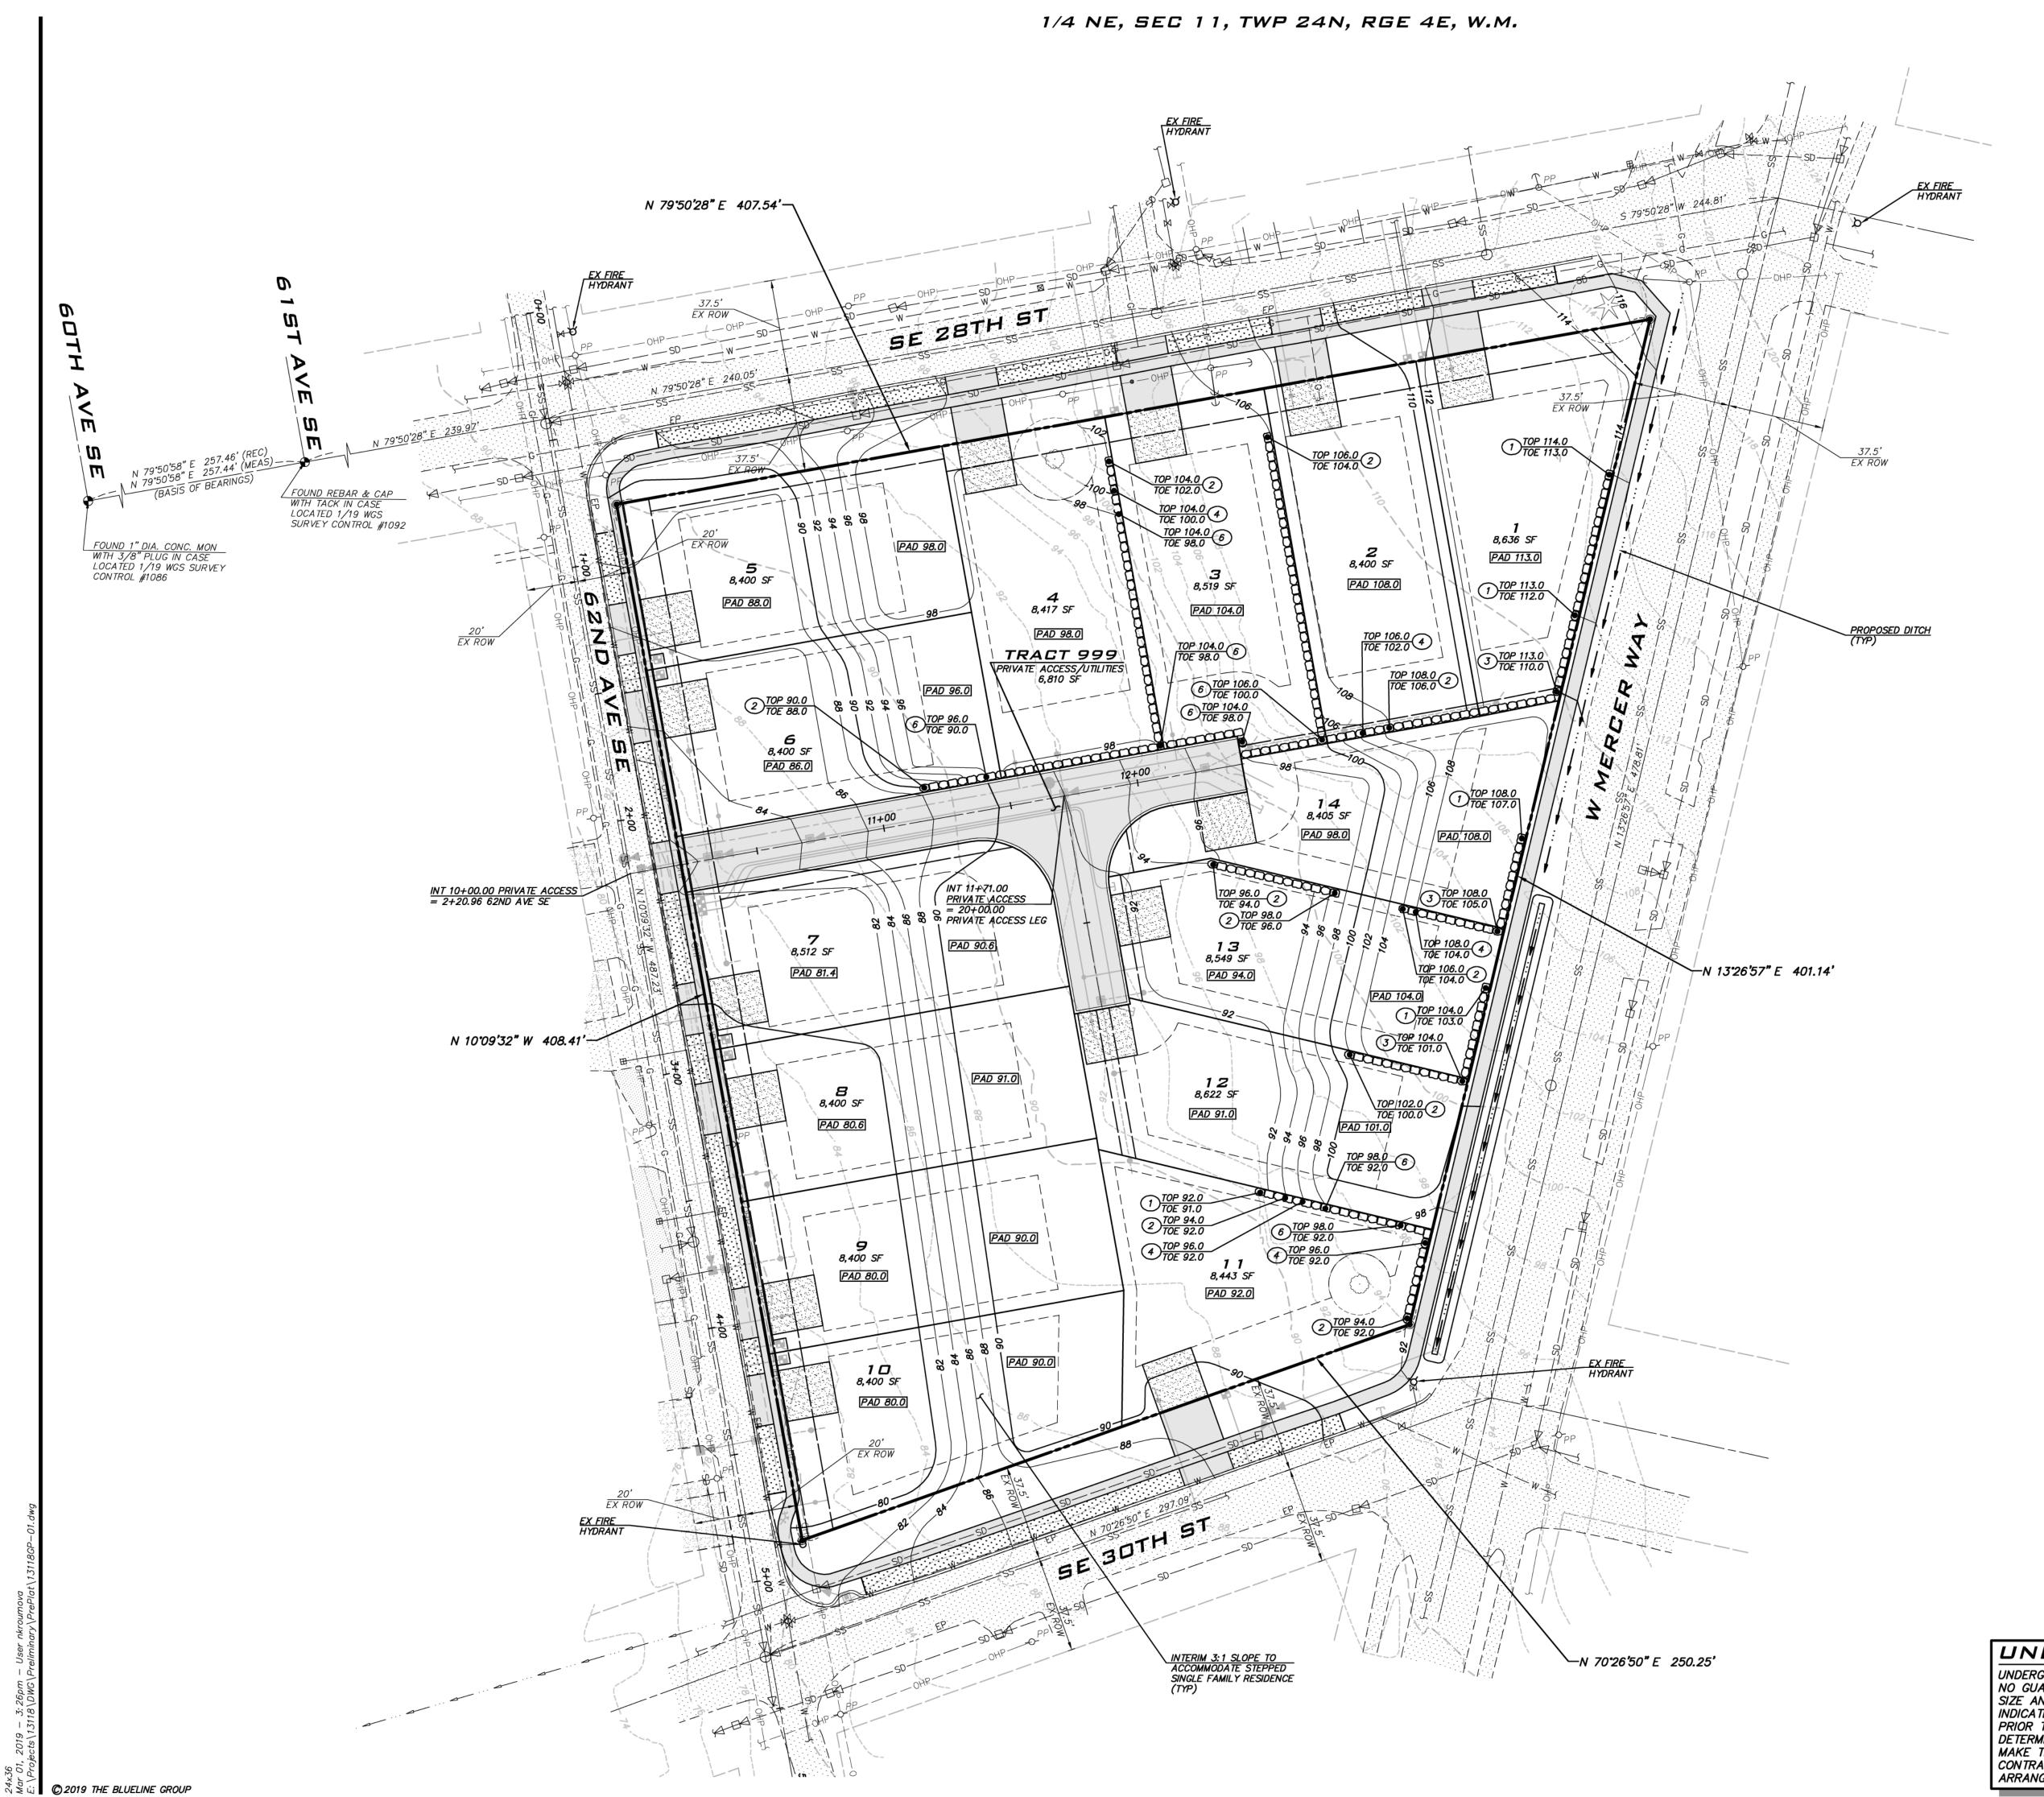



25 CENTRAL WAY, SUITE 400, KIRKLAND, WA 98033 P: 425.216.4051 F: 425.216.4052 WWW.THEBLUELINEGROUP.COM

SCALE: AS NOTED

PROJECT MANAGER: BRETT K. PUDISTS, PE

PROJECT ENGINEER: LYNDSEY MUNKEL, PE NADIA KROUMOVA

ISSUE DATE:

3/1/2019

- AS DESIGNED, NO AREAS EXCEED 6' OF CUT OR FILL.

PRELIMINARY EARTHWORK

NOTE: QUANTITIES ARE PRELIMINARY AND WERE CALCULATED BY

SUBTRACTING FINISHED GRADE FROM EXISTING GRADE.

PAD ELEVATIONS ARE APPROXIMATE AND WILL BE REFINED DURING FINAL DESIGN WHEN PROPOSED BUILDING PLANS ARE

TESC FACILITIES TO BE DESIGNED DURING FINAL ENGINEERING TO PREVENT SEDIMENT LADEN RUNOFF FROM LEAVING THE

UNDERGROUND UTILITY NOTE

6,877 CY 5,930 CY

NOTES

UNDERGROUND UTILITIES ARE SHOWN IN THE APPROXIMATE LOCATION. THERE IS NO GUARANTEE THAT ALL UTILITY LINES ARE SHOWN, OR THAT THE LOCATION, SIZE AND MATERIAL IS ACCURATE. THE CONTRACTOR SHALL UNCOVER ALL INDICATED PIPING WHERE CROSSING, INTERFERENCES, OR CONNECTIONS OCCUR PRIOR TO TRENCHING OR EXCAVATION FOR ANY PIPE OR STRUCTURES, TO DETERMINE ACTUAL LOCATIONS, SIZE AND MATERIAL. THE CONTRACTOR SHALL MAKE THE APPROPRIATE PROVISION FOR PROTECTION OF SAID FACILITIES. THE CONTRACTOR SHALL NOTIFY ONE CALL AT 8-1-1 (WASHINGTON811.COM) AND ARRANGE FOR FIELD LOCATION OF EXISTING FACILITIES BEFORE CONSTRUCTION.



3/1/19

13-118 SHEET NAME: GP-01

BLUELINE

25 CENTRAL WAY, SUITE 400, KIRKLAND, WA 98033 P: 425.216.4051 F: 425.216.4052 WWW.THEBLUELINEGROUP.COM


AS NOTED PROJECT MANAGER: BRETT K. PUDISTS, PE


LYNDSEY MUNKEL, PE NADIA KROUMOVA ISSUE DATE:


3/1/19

13-118 SHEET NAME: RS-01

<u>6</u> of 9

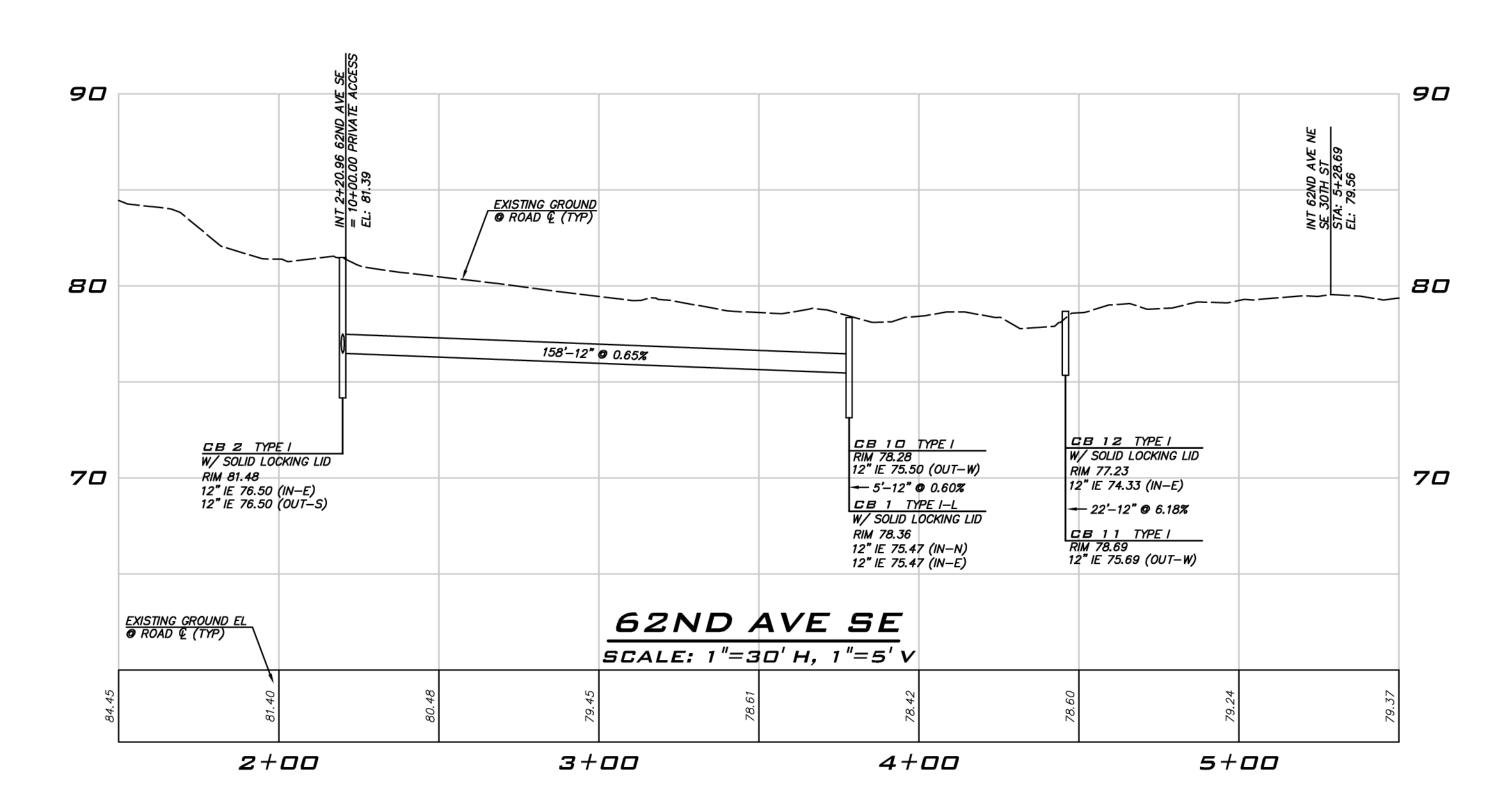

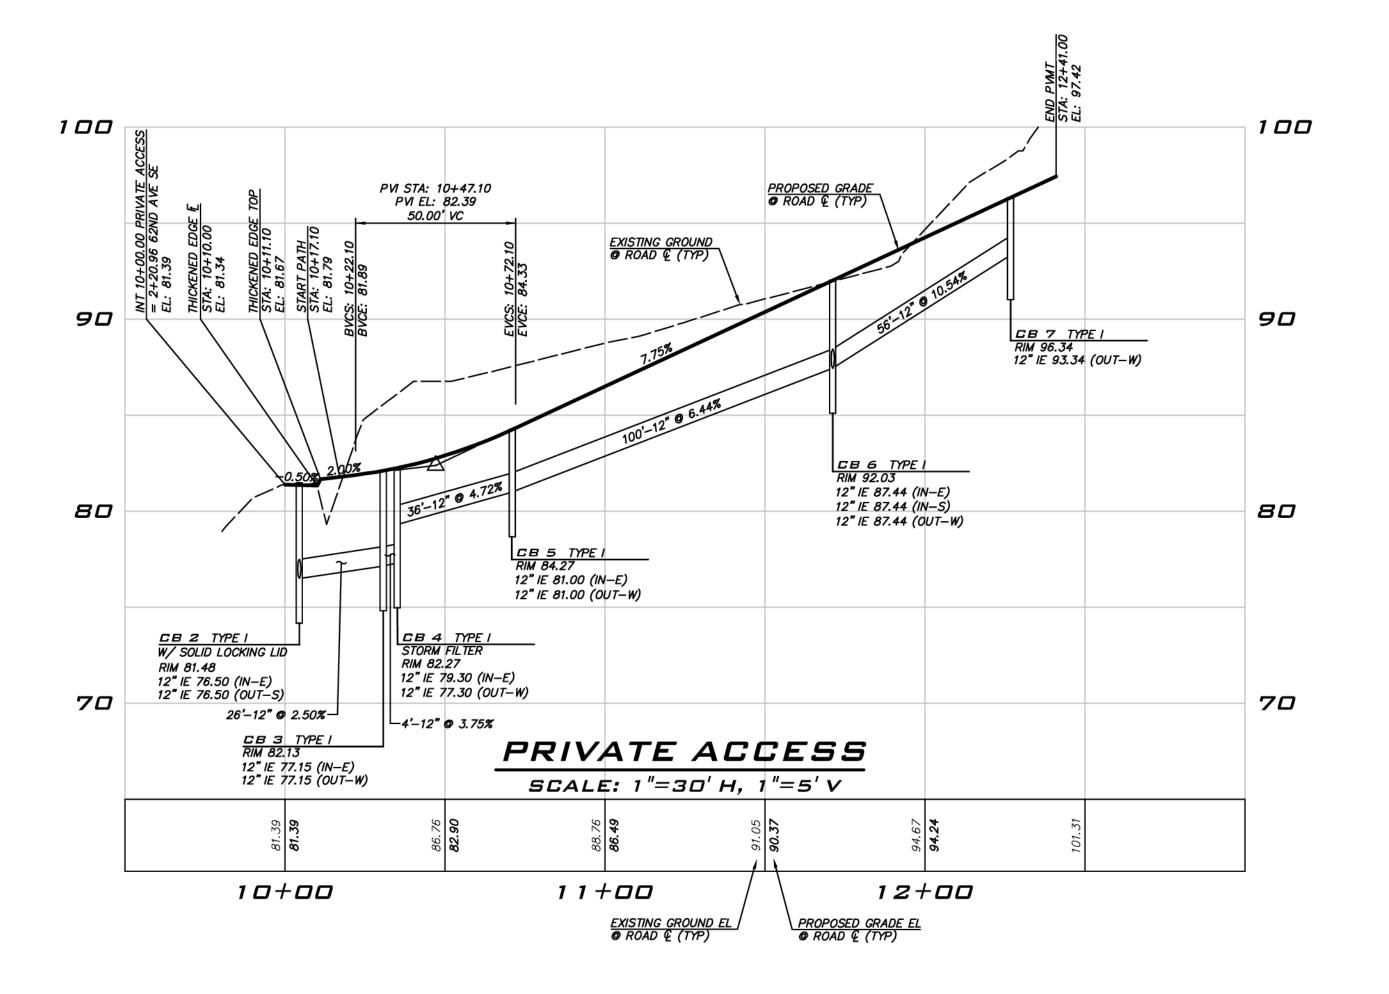

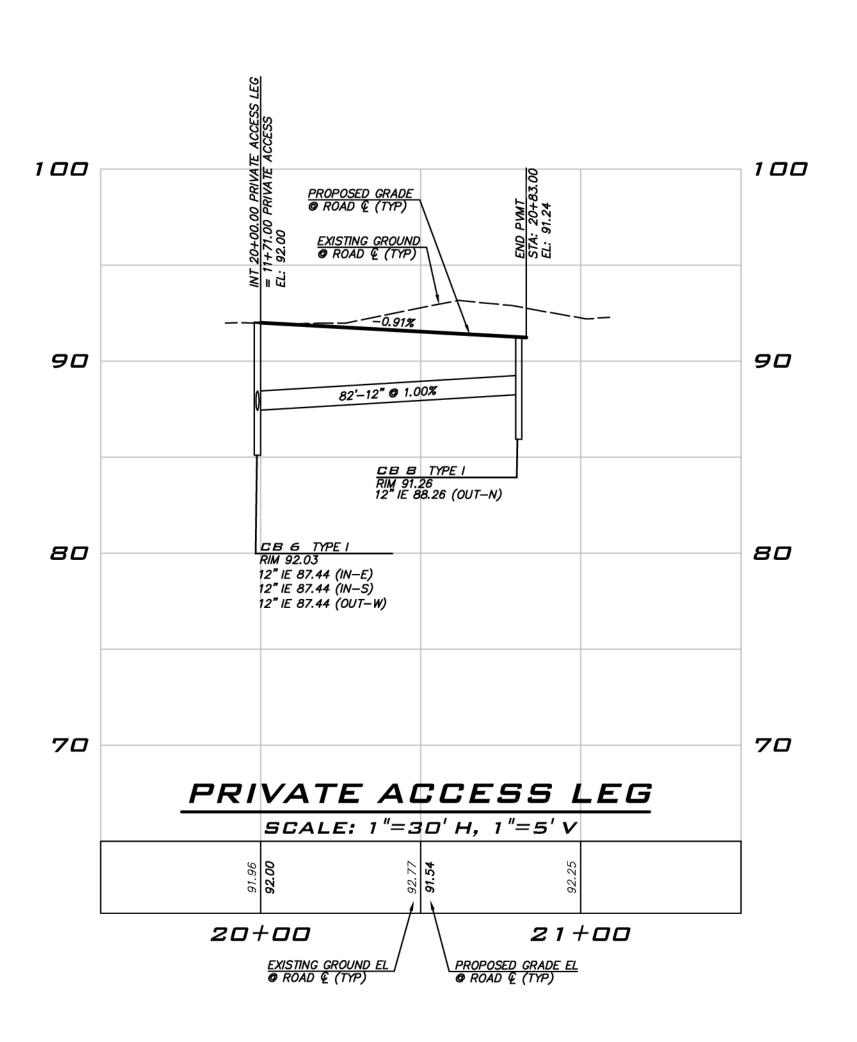

NOTE

NO DIRECT VEHICULAR ACCESS TO W MERCER WAY.

UNDERGROUND UTILITY NOTE

UNDERGROUND UTILITIES ARE SHOWN IN THE APPROXIMATE LOCATION. THERE IS NO GUARANTEE THAT ALL UTILITY LINES ARE SHOWN, OR THAT THE LOCATION, SIZE AND MATERIAL IS ACCURATE. THE CONTRACTOR SHALL UNCOVER ALL INDICATED PIPING WHERE CROSSING, INTERFERENCES, OR CONNECTIONS OCCUR PRIOR TO TRENCHING OR EXCAVATION FOR ANY PIPE OR STRUCTURES, TO DETERMINE ACTUAL LOCATIONS, SIZE AND MATERIAL. THE CONTRACTOR SHALL MAKE THE APPROPRIATE PROVISION FOR PROTECTION OF SAID FACILITIES. THE CONTRACTOR SHALL NOTIFY ONE CALL AT 8-1-1 (WASHINGTON811.COM) AND ARRANGE FOR FIELD LOCATION OF EXISTING FACILITIES BEFORE CONSTRUCTION.



25 CENTRAL WAY, SUITE 400, KIRKLAND, WA 98033 P: 425.216.4051 F: 425.216.4052 WWW.THEBLUELINEGROUP.COM

SCALE: AS NOTED

PROJECT MANAGER: BRETT K. PUDISTS, PE

PROJECT ENGINEER:
LYNDSEY MUNKEL, PE

DESIGNER:
NADIA KROUMOVA

ISSUE DATE: 3/1/2019

/SIDNS

E BY REVISIONS

FILES
NO DATE B

VAY

5 W MERCER WA

X. PUD WASHING WASHING 37925 OF STERENCE

3/1/19

13-118 SHEET NAME: RP-01


7 of 9

C 2019 THE BLUELINE GROUP



TREE REPLACEMENT REQUIREMENT									
REPLACEMENT LOCATION	NUMBER OF TREES								
RIGHT-OF-WAY	20								
PARCELS	18								
TOTAL	38								

	<u>QTY</u>	BOTANICAL NAME / COMMON NAME	<u>CONT</u>	<u>SIZE</u>	NATIVE / ADAPTIVE
)	10	ACER RUBRUM 'BOWHALL' / BOWHALL MAPLE	B & B	2" CAL	NORTHWEST ADAPTIVE
	6	AMELANCHIER X GRANDIFLORA 'AUTUMN BRILLIANCE' / 'AUTUMN BRILLIANCE' SERVICEBERRY	B & B	2" CAL	NORTHWEST ADAPTIVE
À	6	CHAMAECYPARIS NOOTKATENSIS 'PENDULA' / WEEPING NOOTKA FALSE CYPRESS	B & B	8' MIN PLANTED HT.	NORTHWEST ADAPTIVE
	10	PYRUS CALLERYANA 'CHANTICLEER' / CHANTICLEER PEAR	B & B	2" CAL	NORTHWEST ADAPTIVE
1	6	THUJA PLICATA 'EXCELSA' / WESTERN RED CEDAR	B & B	8' MIN PLANTED HT.	NORTHWEST NATIVE

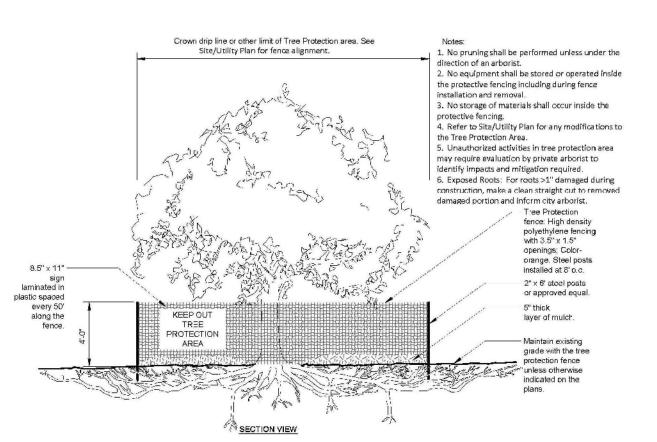

TREE PROTECTION DETAIL NOT TO SCALE

UNDERGROUND UTILITY NOTE

UNDERGROUND UTILITIES ARE SHOWN IN THE APPROXIMATE LOCATION. THERE IS NO GUARANTEE THAT ALL UTILITY LINES ARE SHOWN, OR THAT THE LOCATION, SIZE AND MATERIAL IS ACCURATE. THE CONTRACTOR SHALL UNCOVER ALL INDICATED PIPING WHERE CROSSING, INTERFERENCES, OR CONNECTIONS OCCUR PRIOR TO TRENCHING OR EXCAVATION FOR ANY PIPE OR STRUCTURES, TO DETERMINE ACTUAL LOCATIONS, SIZE AND MATERIAL. THE CONTRACTOR SHALL MAKE THE APPROPRIATE PROVISION FOR PROTECTION OF SAID FACILITIES. THE CONTRACTOR SHALL NOTIFY ONE CALL AT 8-1-1 (WASHINGTON811.COM) AND ARRANGE FOR FIELD LOCATION OF EXISTING FACILITIES BEFORE CONSTRUCTION.



SCALE: AS NOTED PROJECT MANAGER: BRETT K. PUDISTS, PE

PROJECT ENGINEER: LYNDSEY MUNKEL, PE NADIA KROUMOVA

ISSUE DATE: 3/1/2019

3/1/19

13-118 SHEET NAME: TR-0 1

February 21, 2019 Page 9 of 11

Attachment No. 3 – Regulated Tree Inventory (Boldface tree to be retained)

Regulated Threshold	Regulated Category	≥ 24" DBH	Tree No.*	DBH (In.)	QMD	Common name/Latin name	Dripline Radius	Health	Structure	Comments on Condition	Тгее Туре	Tree?
36"	Significant		1	9,16"	18"	Empress tree, Paulownia tomentosa	20'	1	2	Asymmetric canopy	D	No
6"	Exceptional	Yes	2	27"		Madrone, Arbutus menziesii	16'	1	1		BE	Ye
16"	Significant		3	7,7,8,9"	15"	English hawthorn, Crataegus monogyna	12'	2	3	Diseased, stumpsprout	D	No
16"	Exceptional		4	16"		English hawthorn, Crataegus monogyna	15'	2	3	Topped, double leader, over mature	D	No
21"	Exceptional		5	16,16"	23"	Blireiana flowering plum, Prunus blireiana	16'	2	3	Double leader, over mature	D	N
21"	Significant		6	20"		Blireiana flowering plum, Prunus blireiana	16'	2	3	Over mature	D	N
21"	Significant		7	8"		Blireiana flowering plum, Prunus blireiana	15'	2	3	Over mature	D	N
21"	Significant		8	14"		Blireiana flowering plum, Prunus blireiana	14'	3	3	Suckers, over mature, fungal conks on trunk	D	N
16"	Significant		9	8,8,10"	15"	English hawthorn, Crataegus monogyna	18′	2	3	Diseased, topped, stumpsprout	D	N
21"	Significant		10	12"		Blireiana flowering plum, Prunus blireiana	14'	3	3		D	N
21"	Significant		11	12"		Blireiana flowering plum, Prunus blireiana	7'	3	3	Diseased, branch decline, decay	D	Ν
21"	Significant		12	20"		Blireiana flowering plum, Prunus blireiana	16'	3	3	accay	D	Ν
21"	Significant		13	11"		Blireiana flowering plum, Prunus blireiana	12'	1	З	Root failure	D	Ν
21"	Significant		14	11"		Blireiana flowering plum, Prunus blireiana	16'	2	2	Over mature, roots at soil surface	D	N
NR			16	21"		Leyland cypress, Cupressus xLeylandii	16'	1	2	A	С	١
NR			17	12,14"	18"	Leyland cypress, Cupressus xLeylandii	13'	1	2	Asymmetric (hedge against existing building)	С	١
NR		Yes	18	24"		Leyland cypress, Cupressus xLeylandii	15'	1	2	existing building)		N

Registered Consulting Arborist

Mike O'Brien, OB Mercer Island Properties RE: Arborist Report, 2825 West Mercer Way, Mercer Island WA February 21, 2019 Page 10 of 11

Regulated Threshold	Regulated Category	≥24" DBH	Tree No.*	DBH (In.)	QMD	Common name/Latin name	Dripline Radius	Health	Structure	Comments on Condition	Тгее Туре	Viable Tree?
NR			19	12"		Leyland cypress, Cupressus xLeylandii	16'	1	2		С	No
NR		Yes	20	28"		Leyland cypress, Cupressus xLeylandii	16'	1	2		С	No
NR		Yes	21	27"		Leyland cypress, Cupressus xLeylandii	16'	1	2		С	No
NR		Yes	22	34"		Leyland cypress, Cupressus xLeylandii	16'	1	2		С	No
NR			23	21"		Leyland cypress, Cupressus xLeylandii	16'	1	2		С	No
NR		Yes	24	26"		Leyland cypress, Cupressus xLeylandii	16'	1	2		С	No
NR		Yes	25	18,21"	27"	Leyland cypress, Cupressus xLeylandii	16'	1	1		С	Yes
NR		Yes	26	25"		Leyland cypress, Cupressus xLeylandii	16'	1	2		С	No
NR		Yes	27	24"		Leyland cypress, Cupressus xLeylandii	16'	1	2	Asymmetric (hedge against	С	No
NR		Yes	28	31"		Leyland cypress, Cupressus xLeylandii	16'	1	2	existing building)	С	No
NR			29	11"		Portugal laurel, Prunus Iusitanica	10'	1	1		BE	Yes
36"	Significant		30	8,8"	11"	Plum (seedling), Prunus domestica	15'	3	3	Diseased, topped, decay, lean	D	No
36"	Significant		31	14"		Pear, common, Pyrus communis	16'	2	3	Topped, covered in ivy	D	No
16"	Significant		32	8,8,8"	13"	English hawthorn, Crataegus monogyna	15'	2	3	Multiple Idrs, lean, ivy	D	No
NR			33	7,9"	11"	Portugal laurel, Prunus Iusitanica	12'	1	2	Double leader	BE	Yes

NR = Not Regulated

Tree numbers are non-sequential because 3 small trees included in the previous inventory are removed from this report.

Registered Consulting Arborist

CITY OF MERCER ISLAND

DEVELOPMENT SERVICES GROUP 9611 SE 36TH STREET | MERCER ISLAND, WA 98040 PHONE: 206.275.7605 | www.mercergov.org

S:\DSG\FORMS\2017 Forms\Trees\TreeInventory&Replacement

EXCEPTIONAL TREES



TREE INVENTORY & REPLACEMENT SUBMITTAL INFORMATION

species, condition, cultural/historical importance, age, and/or contribution as part with a diameter of more than 36 inches, or with a diameter that is equal to or greatisted in the Exceptional Tree Table shown in MICC 19.16 under Tree, Exceptional.		
List the total number of trees for each category and the tree identification numbers f	rom the arborist	repor
Number of trees 36" or greater	0	
List tree numbers:		
Number of trees 24" or greater (including 36" or greater)	1	
List tree numbers: 2		
Number of trees from Exceptional Tree Table (MICC 19.16)	3	
List tree numbers: 2, 4, 5	·	
LARGE REGULATED TREES		
EARCE REGULATED TREES		
Large Regulated Trees- means any tree with a diameter of 10 inches or more, and definition of an Exceptional Tree.	any tree that me	ets ti
Large Regulated Trees- means any tree with a diameter of 10 inches or more, and	any tree that me	
<u>Large Regulated Trees</u> - means any tree with a diameter of 10 inches or more, and definition of an Exceptional Tree.		
<u>Large Regulated Trees</u> - means any tree with a diameter of 10 inches or more, and definition of an Exceptional Tree. Number of Large Regulated Trees on site		(.
Large Regulated Trees- means any tree with a diameter of 10 inches or more, and definition of an Exceptional Tree. Number of Large Regulated Trees on site List tree numbers: 1-6, 8-14, 30-32 Number of Large Regulated Trees on site proposed for removal	16	(,
Large Regulated Trees- means any tree with a diameter of 10 inches or more, and definition of an Exceptional Tree. Number of Large Regulated Trees on site List tree numbers: 1-6, 8-14, 30-32 Number of Large Regulated Trees on site proposed for removal List tree numbers: 1, 3, 5, 6, 8-12, 14, 30-32 Percentage of trees to be retained ((A-B)/Ax100) note: must be at least 30%	16 13 19 al replacement trees	(,
Large Regulated Trees- means any tree with a diameter of 10 inches or more, and definition of an Exceptional Tree. Number of Large Regulated Trees on site List tree numbers: 1-6, 8-14, 30-32 Number of Large Regulated Trees on site proposed for removal List tree numbers: 1, 3, 5, 6, 8-12, 14, 30-32 Percentage of trees to be retained ((A-B)/Ax100) note: must be at least 30%	16 13 19 al replacement trees offset lower percent	(, (have
Large Regulated Trees- means any tree with a diameter of 10 inches or more, and definition of an Exceptional Tree. Number of Large Regulated Trees on site List tree numbers: 1-6, 8-14, 30-32 Number of Large Regulated Trees on site proposed for removal List tree numbers: 1, 3, 5, 6, 8-12, 14, 30-32 Percentage of trees to be retained ((A-B)/Ax100) note: must be at least 30% RIGHT OF WAY TREES *4 additional included to	16 13 19 al replacement trees offset lower percent	(/ (have
Large Regulated Trees- means any tree with a diameter of 10 inches or more, and definition of an Exceptional Tree. Number of Large Regulated Trees on site List tree numbers: 1-6, 8-14, 30-32 Number of Large Regulated Trees on site proposed for removal List tree numbers: 1, 3, 5, 6, 8-12, 14, 30-32 Percentage of trees to be retained ((A-B)/Ax100) note: must be at least 30% RIGHT OF WAY TREES *4 addition included to Right of Way Trees- means a tree that is located in the street right of way adjacent to	16 13 19 al replacement trees offset lower percent	(/ (I

Updated 11/29/2017

Page | 1

List tree numbers: 3, 5, 6, 10-12, 31, 32

Reason for removal: 3, 10-12 — diseased; 5 — overmature & non-viable; 31 & 32 — covered in ivy & non-viable

TREE REPLACEMENT

Tree replacement- removed trees must be replaced based on the ratio in the table below. Replacement trees shall be conifers at least six feet tall and or deciduous at least one and one-half inches in diameter at

			Number of Tree
	Tree	Number of	Required for
Diameter of Removed Tree (measured 4.5'	replacement	Trees Proposed	Replacement Based
above ground)	Ratio	for Removal	on Size/Type
Less than 10"	1	4	4
10" up to 24"	2	12	24
Greater than 24" up to 36"	3	0	0
Greater than 36" and any Exceptional Tree	6	1	6

TOTAL TREE REPLACEMENTS 34 - required

retention percentage)

S:\DSG\FORMS\2017 Forms\Trees\TreeInventory&Replacement

Updated 11/29/2017

Page | 2

BLUELINE

25 CENTRAL WAY, SUITE 400, KIRKLAND, WA 98033 P: 425.216.4051 F: 425.216.4052 WWW.THEBLUELINEGROUP.COM

AS NOTED

PROJECT MANAGER: BRETT K. PUDISTS, PE

PROJECT ENGINEER: LYNDSEY MUNKEL, PE

NADIA KROUMOVA

3/1/2019

3/1/19

13-118 SHEET NAME: TR-02

UNDERGROUND UTILITIES ARE SHOWN IN THE APPROXIMATE LOCATION. THERE IS NO GUARANTEE THAT ALL UTILITY LINES ARE SHOWN, OR THAT THE LOCATION, SIZE AND MATERIAL IS ACCURATE. THE CONTRACTOR SHALL UNCOVER ALL INDICATED PIPING WHERE CROSSING, INTERFERENCES, OR CONNECTIONS OCCUR PRIOR TO TRENCHING OR EXCAVATION FOR ANY PIPE OR STRUCTURES, TO DETERMINE ACTUAL LOCATIONS, SIZE AND MATERIAL. THE CONTRACTOR SHALL MAKE THE APPROPRIATE PROVISION FOR PROTECTION OF SAID FACILITIES. THE CONTRACTOR SHALL NOTIFY ONE CALL AT 8-1-1 (WASHINGTON811.COM) AND ARRANGE FOR FIELD LOCATION OF EXISTING FACILITIES BEFORE CONSTRUCTION.